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THEATRE EQUIPMENT (TE)

SPECIFICATION LIST

- 11062 PERFORMANCE DRAPERIES
- 11063 PERFORMANCE PLATFORMS
- 11064 PERFORMANCE RIGGING
- 11065 PROSCENIUM SAFETY CURTAIN
- 11941 STAGE LIFT SYSTEM

DRAWING LIST

- TE-01 KEY DRAWINGS
- TE-02 SIGHTLINES & MASKING
- TE-03 STAGE PLANS
- TE-04 STAGE RIGHT & STAGE LEFT ELEVATIONS
- TE-05 SAFETY CURTAIN
- TE-06 TYPICAL LINESETS
- TE-07 MISCELLANEOUS RIGGING
- TE-08 ADJUSTABLE PROSCENIUM LEGS
- TE-09 STAGE LIFT SYSTEM - 1 OF 2
- TE-10 STAGE LIFT SYSTEM - 2 OF 2
- TE-11 HOUSE MIX PLATFORMS
- TE-12 TECP & TE ELECTRICAL RISERS

ABBREVIATIONS

- CL CENTER LINE
- CTR CENTER
- DS DOWNSTAGE
- DSL DOWNSTAGE LEFT
- DSR DOWNSTAGE RIGHT
- EC ELECTRICAL CONTRACTOR
- FOH FRONT-OF-HOUSE
- HL HOUSE LIGHT(S)
- HSE HOUSE (AUDITORIUM)
- HSE LFT HOUSE LEFT
- HSE RT HOUSE RIGHT
- LB LIGHTING BRIDGE
- MB MARSHALLING BOX
- MIDSTG MIDSTAGE
- NIC NOT IN CONTRACT
- PL PERFORMANCE LIGHTING
- PLM PERFORMANCE LIGHTING MANUFACTURER
- SL STAGE LEFT
- SLL SOUND & LIGHT LOCK
- SR STAGE RIGHT
- STG STAGE
- TE THEATRE EQUIPMENT
- TEC THEATRE EQUIPMENT CONTRACTOR
- US UPSTAGE

The general contractor shall conduct meetings to review architectural, structural, mechanical and theater designs, plans and details. The purpose of these meetings is coordination of the trades, and to identify issues requiring review and coordination. The meetings are to occur at least three weeks prior to the start of the work to be discussed and shall be attended by all parties involved in the specific phase of construction.

These meetings shall be attended by, but not be limited to the following: representatives from the architect, structural engineer, mechanical engineer, theater contractor, general contractor, structural steel, masonry, mechanical, theater equipment, and rigging contractors, and owner's inspection agency.

Prior to these meetings, the shop drawings related to structure, mechanical, theater equipment and rigging must have been submitted to and reviewed by the general contractor and the design team.

REFER TO ARCHITECTURAL, STRUCTURAL, ELECTRICAL & MECHANICAL DRAWINGS FOR DETAILS & LOCATIONS OF STRUCTURE & SERVICES. DO NOT USE THESE DRAWINGS TO DETERMINE DETAILED POSITIONS OF WORK BY OTHER TRADES. FIELD VERIFY ALL CONDITIONS & DIMENSIONS.

DESCRIPTION	DESCRIPTION
AS BUILT REVISIONS	
SUBMITTED	ARCHITECT (ENGINEER)
SUBMITTED	ENGINEER (ARCHITECT)
REVIEWED BY DEPARTMENT OF	
REVIEWED BY DEPARTMENT OF GENERAL SERVICES	

SEALS

COMMONWEALTH OF PENNSYLVANIA
DEPARTMENT OF GENERAL SERVICES
 HARRISBURG, PENNSYLVANIA

PROJECT NO. D.G.S. 412- 49

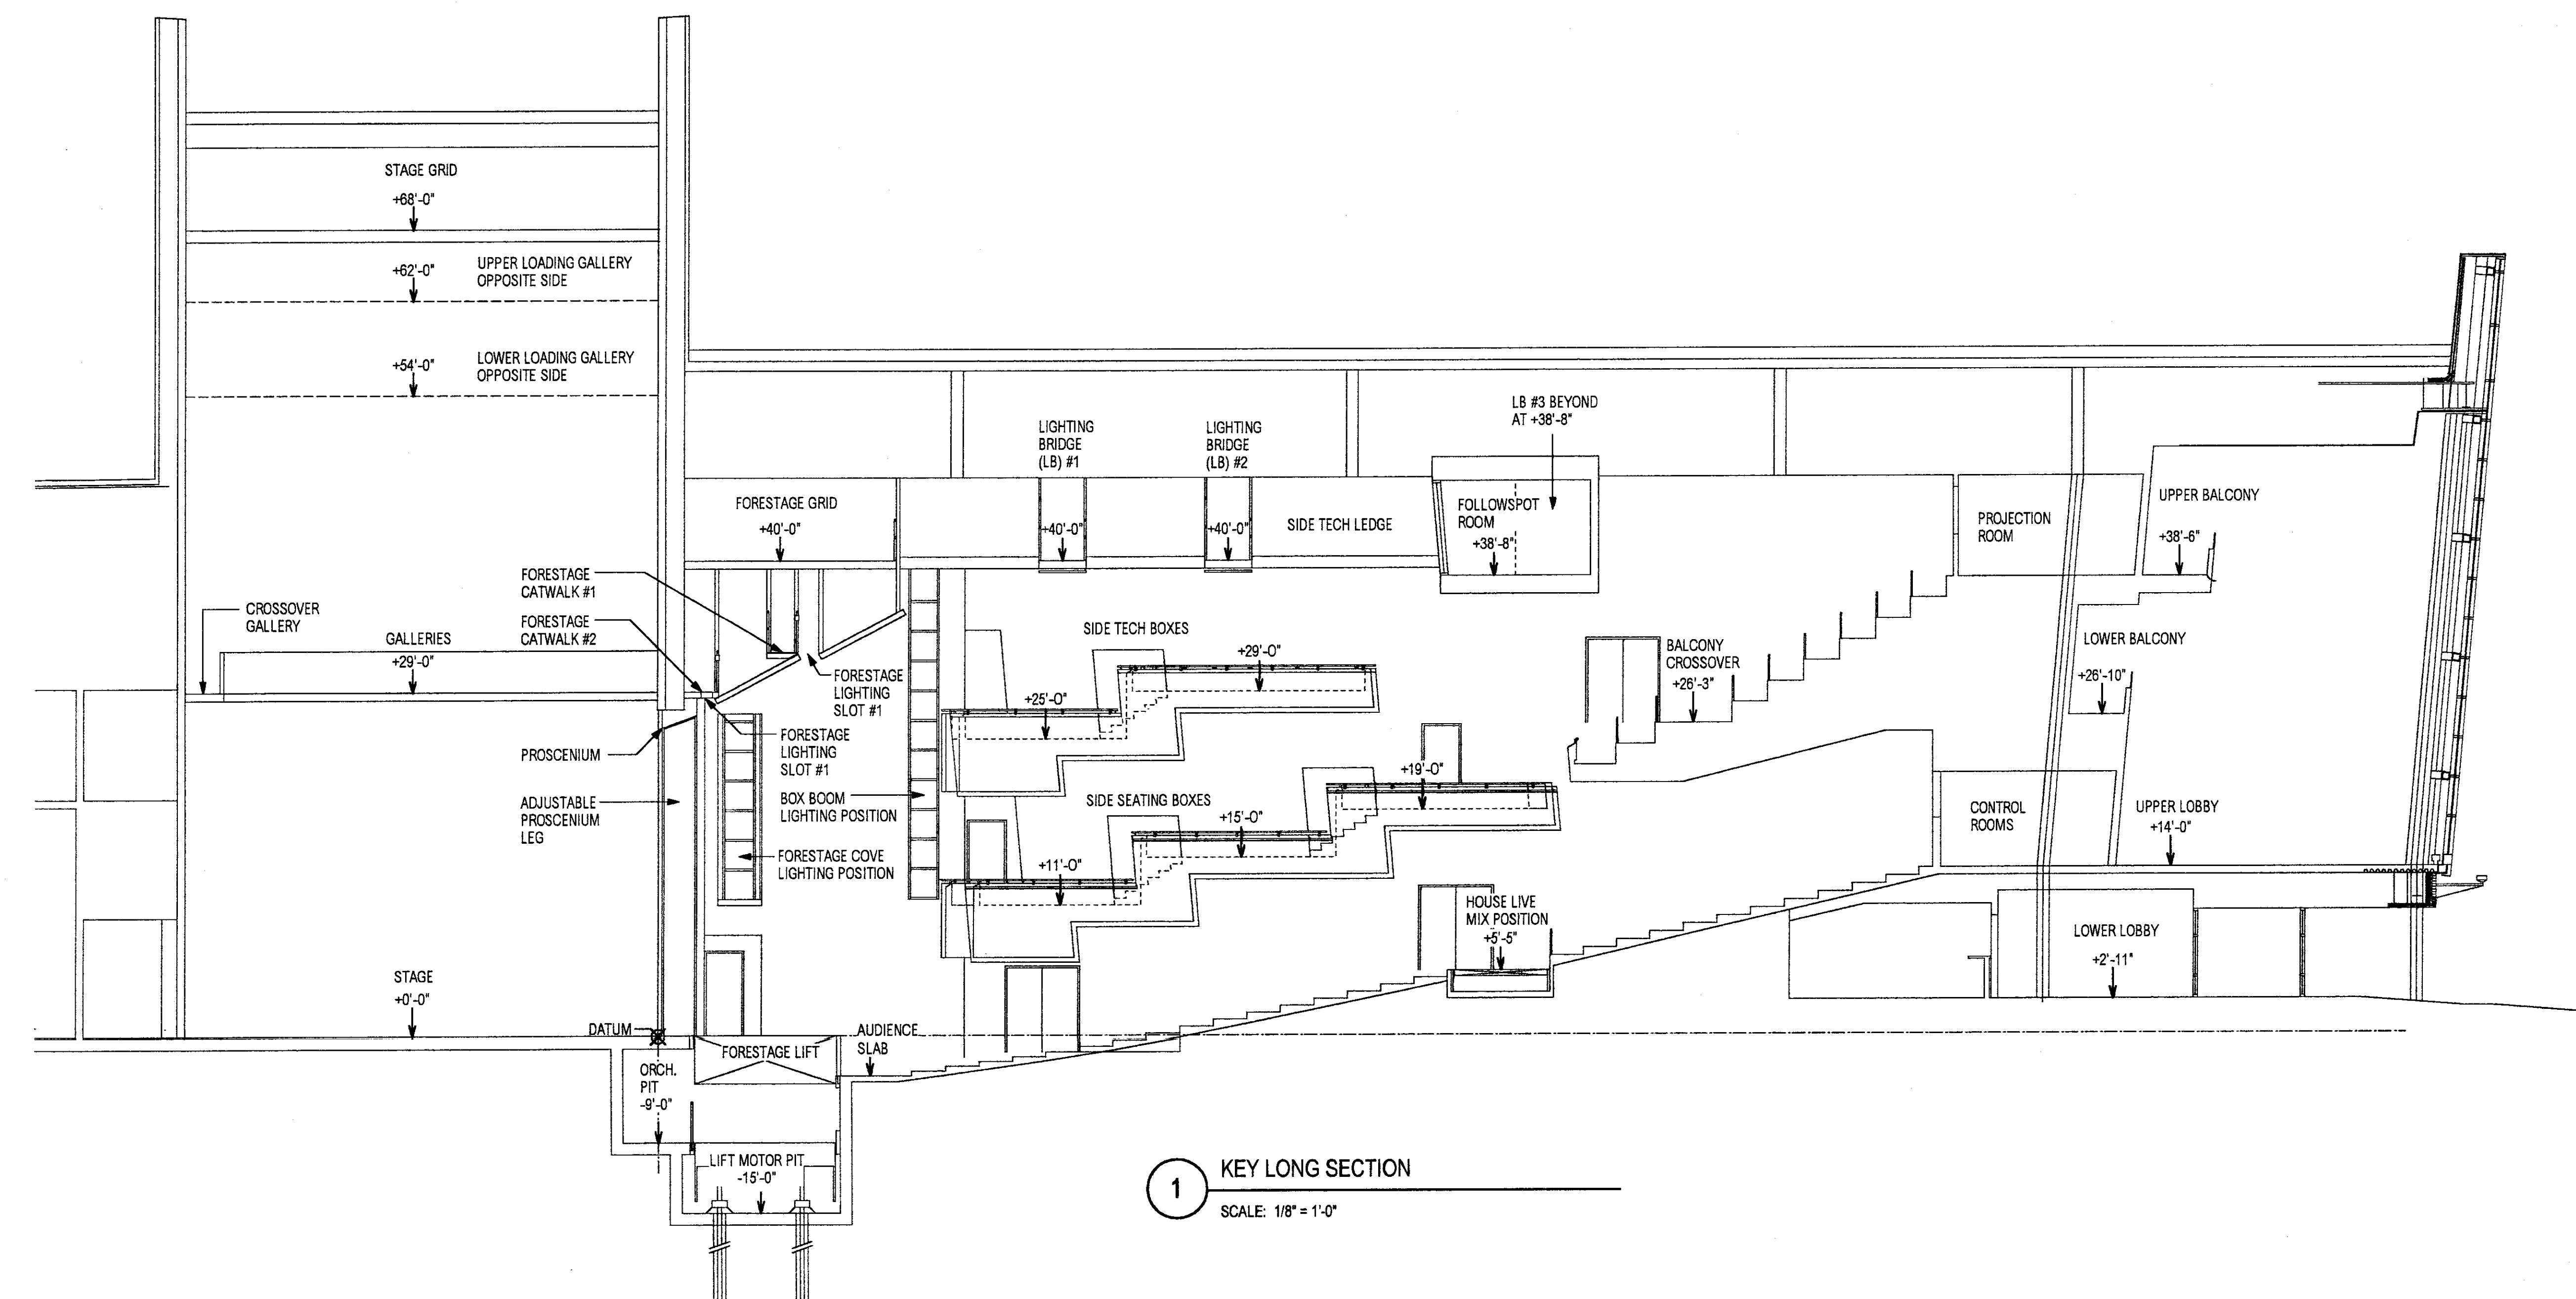
INSTRUCTIONAL ARTS FACILITY
 SHIPPENSBURG UNIVERSITY,
 FRANKLIN AND CUMBERLAND COUNTIES, PA

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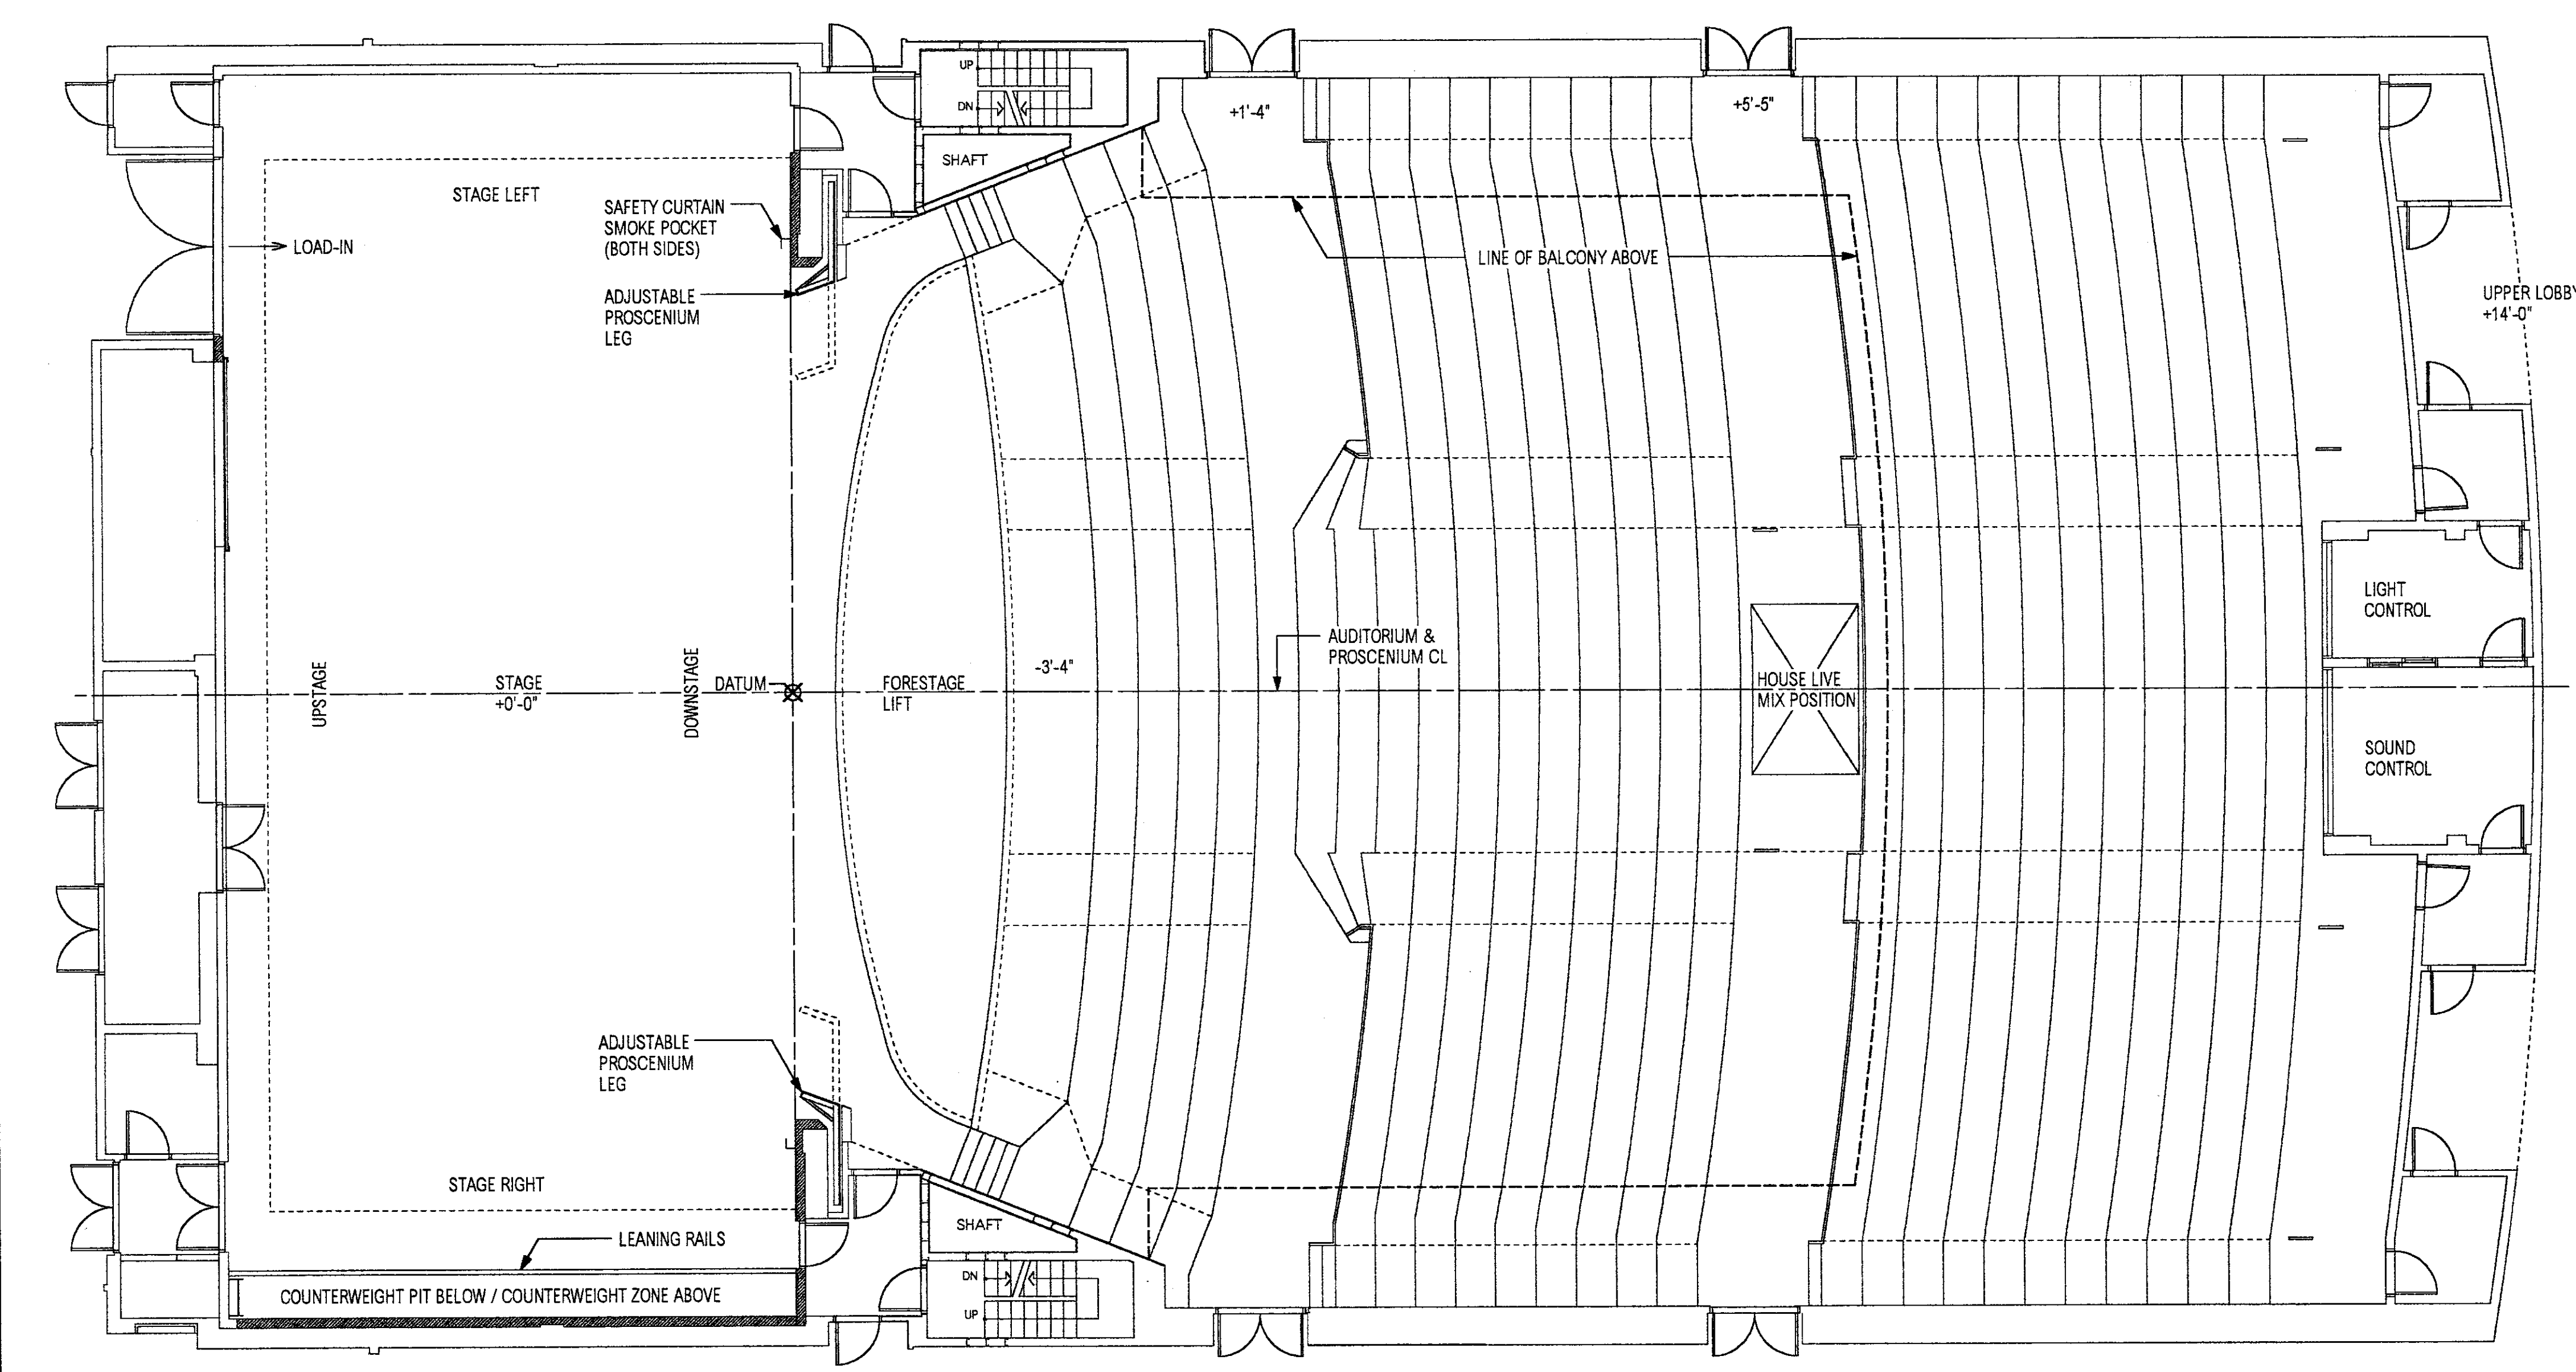
THEATRE EQUIPMENT KEY DRAWINGS

DRAWN BY:	DATE:	DRAWING NO.:
CA	JULY 1, 2003	TE-01
CHECKED BY:	SCALE:	
JT	AS NOTED	

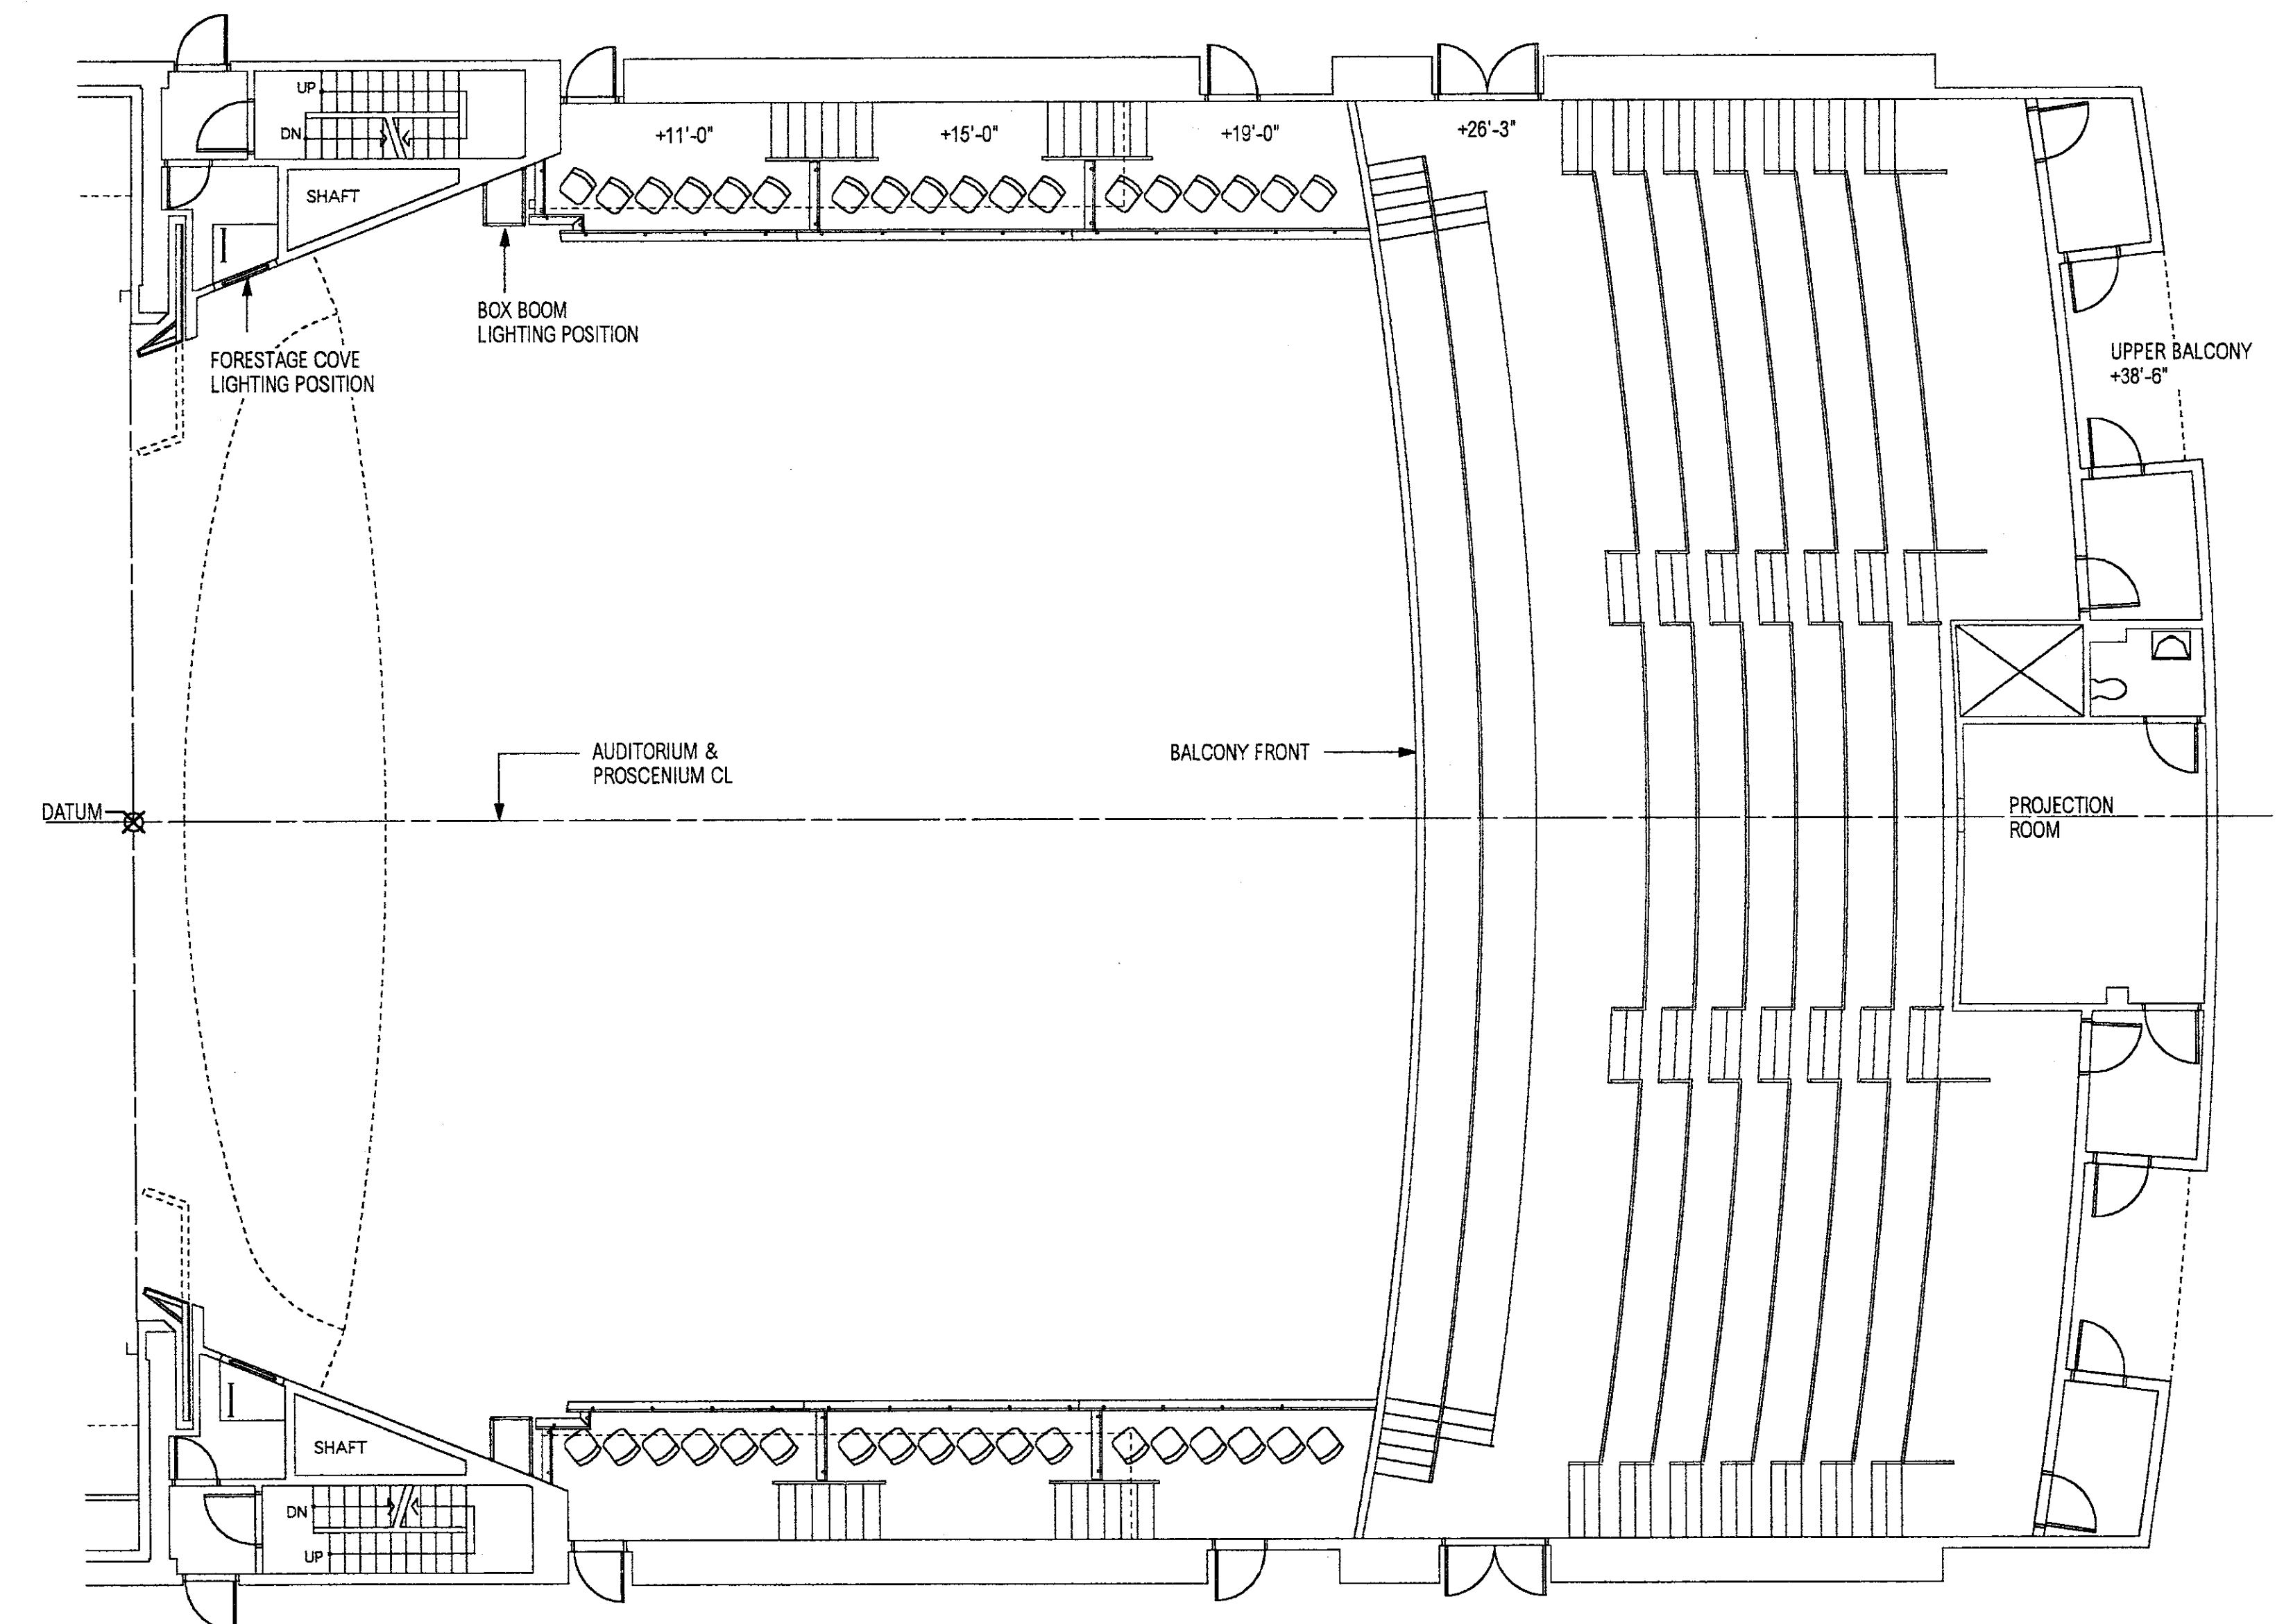
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1 KEY LONG SECTION
 SCALE: 1/8" = 1'-0"



2 KEY PLAN - MAIN LEVEL
 SCALE: 1/8" = 1'-0"



3 KEY PLAN - BALCONY LEVEL
 SCALE: 1/8" = 1'-0"